C.1.01 C.G.01 Total: 2

C.1.09

C.G.09

Total: 2

GENERAL NOTES:

DETAILS AND CONSTRUCTION JOINTS.


ARRANGEMENT PLANS AND LAYOUTS .


UNLESS NOTED OTHERWISE.


THICKNESSES .



Reflected Ceiling Plan - Type 1K
Type 1KM Similar (Mirrored)

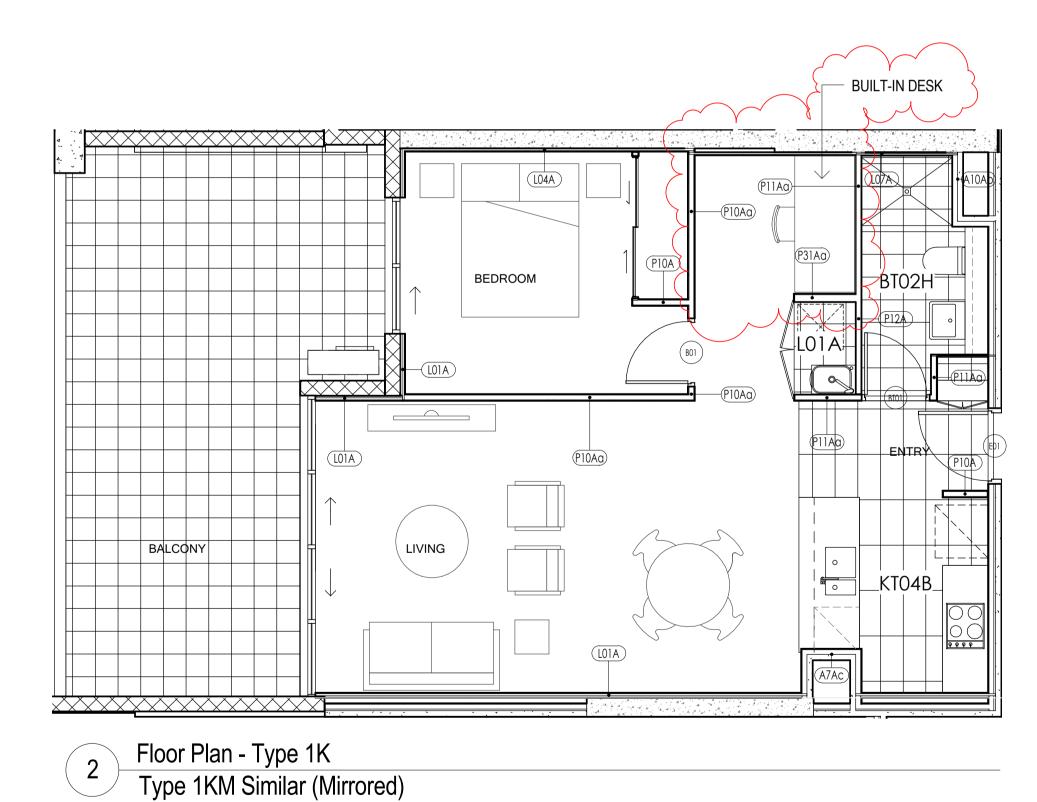

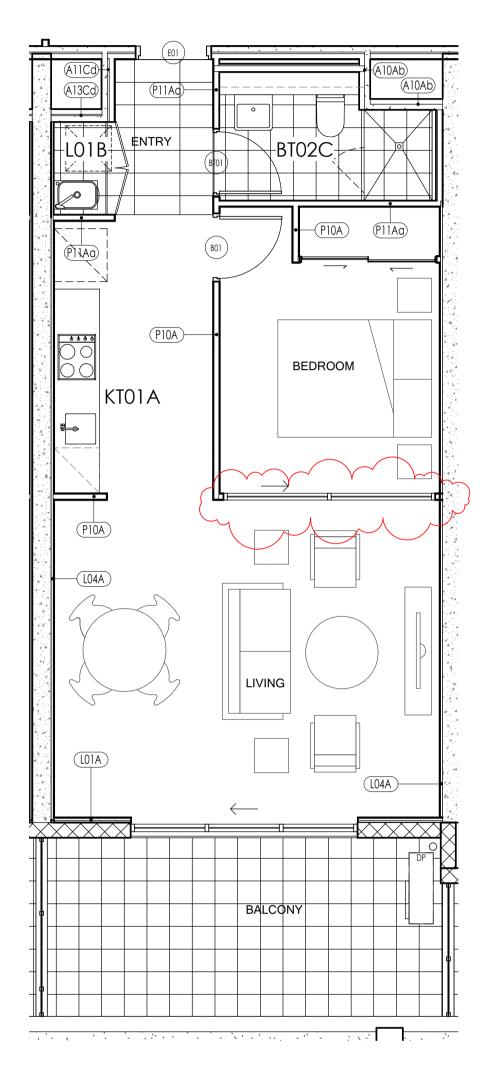

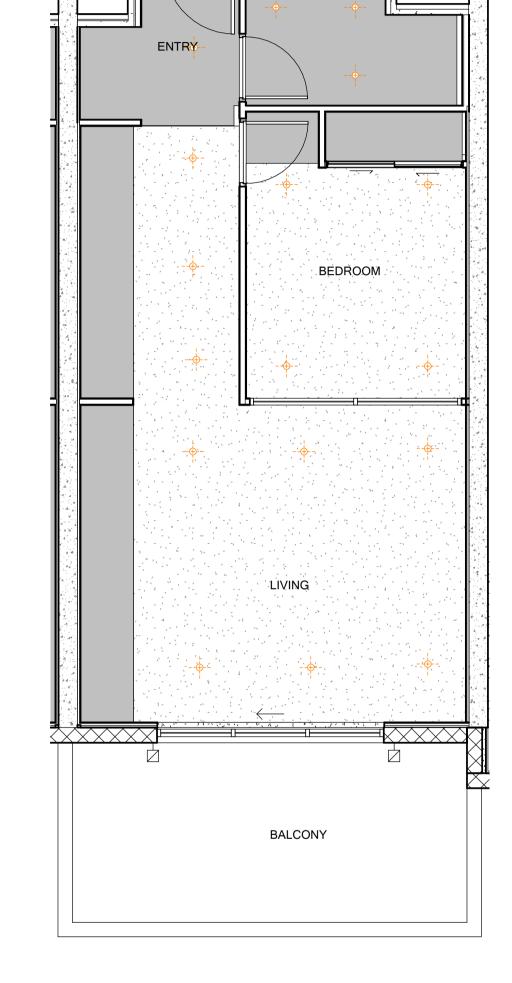

FOR BATHROOM LAUNDRY AND KITCHEN

LIGHTING REFER TO A11.00 SERIES

Reflected Ceiling Plan - Type 1J Type 1JM Similar (Mirrored)

UNIT NUMBERS FOR UNIT LAYOUT TYPE 1J

B.1.12

Total: 1

UNIT NUMBERS FOR UNIT LAYOUT TYPE 1JM

B.1.13 Total: 1

DA Design Condition Revisions 26-08-2016 Revised Tender Issue-Modification to Suit Revised Design of Building A 29-04-2016 Issued for Information DO NOT SCALE from this drawing. Use given dimensions only. Check all dimensions on the job prior to commencement of shop

drawings or fabrication. Any discrepancies are to be referred to the

Architect/Engineer/Designer prior to commencement of work

Scale 1: 50 0 500 1000 2500 KAPAU HOLDINGS PTY LTD

A207, 339 SUSSEX STREET, SYDNEY, NSW 2000 AUSTRALIA Tel: 9299 9987 Fax: 9262 6827

BURWOOD GRAND MIXED USE RESIDENTIAL DEVELOPMENT BELMORE ST, CONDER STREET, WYNNE AVENUE

BURWOOD NSW

KANNFINCH

Kann Finch Group Pty Ltd 50 Carrington St Sydney NSW 2000 ACN 139 614 798 Tel +61 2 9299 4111 www.kannfinch.com Nominated Architect: Stephen Jamison NSW ARB Reg No 5108

UNIT LAYOUT TYPES 1J & IJM & 1K & 1KM

Scale:

A8.14 Issue: Drawn: Checked: Proj.No: 01/2016 SG 6335

Central_benny.zheng.rvt

WHERE THERE IS A DISCREPANCY BETWEEN ANY REQUIREMENTS OF THE REPORTS AND SCHEDULES AND THESE DRAWINGS, THE ARCHITECT MUST BE CONSULTED. CEILINGS MUST BE FLUSH SET AND LEVEL ACROSS ALL DOOR HEADS BULKHEADS REQUIRED FOR MECHANICAL VENTILATION DUCTS TO BE CONFRIMED BY MECHANICAL ENGINEER .MAX.WIDTH 500-700MM. BULKHEADS REQUIRED FOR HYDRAULIC PIPES TO BE CONFRIMED BY HYDRAULIC ENGINEER.MAX.WIDTH 200MM. IN ALL OTHER CONDITIONS CEILING HEIGHTS TO SOFFIT OF BULKHEAD MUST ACHIEVE 2400MM CLEARANCE AFFL. FOR LIGHT FITTINGS SPECIFICATION REFER TO ELECTRICAL CONSULTANT'S DOCUMENTATION AND SCHEDULE REFER TO A4.00 SERIES FOR UNIT TYPE LAYOUTS AND LOCATIONS SCHEDULE & LAYOUT SPECIFY REQUIREMENTS & SHOW EXTENT ONLY. DETAILING REQUIREMENTS NEED TO BE IN ACCORDANCE WITH MANUFACTURES DETAILS & SPECIFIC RECOMMENDATIONS. LEGEND: INDICATES EXTENT OF 2700 CEILING ABOVE FINISHED FLOOR LEVEL, SQUARE SET UNO. RONDO P50 SHADOW LINE STOPPING ANGLE WHERE ABUTTING PERIMETER WALLS INDICATES EXTENT OF 2400 CEILING ABOVE FINISHED FLOOR LEVEL, SQUARE SET UNO. RONDO P50 SHADOW LINE STOPPING ANGLE WHERE ABUTTING PERIMETER WALLS CEILING ,SQUARE SET AT 2750 ABOVE FINISHED FLOOR LEVEL AT BALCONY SLIDING DOORS ONLY. DOWNLIGHT EXTERNAL BALCONY WALL LIGHT 00 DOOR TAG, REFER TO 13.77 DOOR SCHEDULE WALL TYPE TAG, REFER TO DWG 8.00 & 8.11 FOR WALL TYPES

ABT00 DENOTES ACCESSIBLE BATHROOM TYPE,

FOR KITCHEN TYPES REFER TO A11.30 SERIES FOR BATHROOM TYPES REFER TO A11.40 SERIES

FLUSH SET 13MM PLASTERBOARD CEILINGS AND BULKHEADS

TREATMENT OF PIPES AS INDICATED IN ACOUSTIC REPORT)

DUSK SCHEME FINISHES -REFER TO FINISHES SCHEDULE

DAWN SCHEME FINISHES-REFER TO FINISHES SCHEDULES

SUSPENDED FROM SLAB SOFFIT .(50MM INSULATION TO CEILING

AREAS FOR BULKHEADS AND OPEN SPACE AREAS ABOVE INCLUDING

FLUSH SET 13MM MOISTURE RESISTANT PLASTERBOARD CEILINGS AND BULKHEADS SUSPENDED FROM SLAB SOFFIT WITH 50MM INSULATION PER ACOUSTIC SPECIFICATION (TO WET AREAS ONLY)

TEXTURED PAINT TO BALCONY SOFFIT REFER TO EXTERNAL FINISHES

TFB1- TIMBER FLOOR (OPTION 1) FOR LIVING AREAS AND BEDROOM OR

TF1- TILED FLOOR (OPTION 2) FOR LIVING AREAS AND C1 CARPET FOR

TFB1-TIMBER FLOOR (OPTION 1) FOR LIVING AREAS AND BEDROOM OR TF2-TILED FLOOR (OPTION 2) FOR LIVING AREAS AND C2 CARPET FOR

ALL FLOOR FINISHES SHOULD BE MEASURED FROM THE FINISHED FLOOR FOR OPTION 1 THE TILED FLOOR AT THE ENTRY OF EACH APARTMENT WILL RAMP UP TO ACHIEVE THE OVERALL THICKNESS OF THE TIMBER FLOOR.

FOR LAUNDRY, LINEN AND WARDROBE TYPES REFER TO A11.44

DENOTES LAUNDRY TYPES

DENOTES LINEN TYPES

BT00 DENOTES BATHROOM TYPES DENOTES KITCHEN TYPES

KT00

CEILING TYPE

FINISHES OPTIONS

TF3-TILED FLOOR FOR WET AREAS

TF4-TILED FLOOR FOR WET AREAS

REFER DWG A11.81 FOR THRESHOLD DETAILS

UNIT NUMBERS FOR UNIT LAYOUT TYPE 1K

UNIT NUMBERS FOR UNIT LAYOUT TYPE 1KM

REFER TO WALL SETOUT DRAWINGS SERIES A2.00 SERIES AND WALL TYPE

REFER TO STRUCTURAL ENGINEER'S DRAWINGS FOR STRUCTURAL SIZES

CONSULTANTS DOCUMENTATION AND THE ACOUSTIC ,BASIX ,BCA ,ACCESS

WALL LINING FOR THE FREE STANDING CONCRETE WALLS TO BE L03A

UNIT TYPE IS TYPICAL BUT CAN SLIGHTLY VARY IN LENGHT OR WIDTH INCLUDING STRUCTURAL COMPONENTS USED FOR EACH BUILDING AND

THIS DRAWING IS TO BE READ IN CONJUNCTION WITH SERVICES

AND FINISHES AND FIXTURE SCHEDULES AND REPORTS. FOR BALCONY AND FACADE WALLS REFER TO A2.00 GENERAL

DETAILS A8.00 SERIES FOR INTERTENANCY WALLS AND WALL

Z Ш

Drawing No:

1:50 Plot Date: 2/11/2016 5:02:36 PM CAD File: C:\Users\benny.zheng\Documents\6335 Belmore St Burwood CONTROL -